

Pre-Bid Meeting Agenda

Brunswick Building Demolition & New Parking – C20193118

Brunswick University Center, Brunswick, Ohio Thursday, April 29, 2021 @ 10:00 AM

Attendees:

Michele Crawford-Tri-C / Michele.Crawford@tri-c.edu Bob Ledinsky, Tri- C /.Ledinsky@tri-c.edu Mike Christopher, RE Warner / MChristopher@rewarner.com Robert P. Lackowski, RE Warner / RLackowski@rewarner.com

Alex DeNigris- Fabrizi / alex@fabrizi-inc.com
Phil Strever- Platform Contracting / phil@platformcontracting.com
Dominic Velotta- Ohio Paving / dvelotta@ohiopaving.com
Devin Jaran / Rick Kuehn Sitetech Excavating / rickk@sitetechexcavating.com
Rhoni Thompson, R.L. Cole Enterprise, Inc. / rlcoleenterpriseinc@gmail.com / 216-316-0281
Jayesh Dharia- Neroni & Sons / jayesh@nerone.biz
Nick Gomula Infinity paving / nick@infinitypaving.com

A. Overview of Project Scope

This project includes existing church building demolition as well as existing parking lot improvements and expansion. The new lot will increase parking capacity at the current Tri-C Brunswick University Center located at 3611 Center Road. It also will add site lighting, security features and landscaping.

C. Delivery Method

This project is a general contracting project general contracting project

D. Bidding & Award Timeline

The following points were reviewed, and all interested bidders were encouraged to read through the bidding documents in detail:

- Bids due Friday May 14, 2021 @ 2:00PM / District Office
- Bid Opening @ 2:10 PM / District Office
- RFI Questions submitted by Friday May 7, 2021 (We have to get an addendum out by 5/11 for the 72-hour rule) Questions should be submitted to RE Warner.
- Substitutions are 10 days before the bid opening by 4/30.



E. Schedule

Construction is scheduled to begin at the beginning of July. There is a little lag here so all the necessary board approvals can be completed. The Tri-C board is at the end of June and Brunswick Planning Commission is at the end of May. The substantial completion date is September 24, 2021.

G. Review of Bidding Document Drawings

- Re Warner gave brief overview of the project and reviews all the sheets in the drawings package. It was noted that there is a chance additional lighting along excellence drive may be added but coordination is ongoing with the utility company.

H. Questions

- There was a question about the bidding of the packages. The bid packages should be combined in the base bid.
- There was a question about the list of attendees being distributed. The meeting attendees and minutes will be included in an addendum.

SECTION 01 23 00 - ALTERNATES

PART 1 - GENERAL

1.1 SUMMARY

A. Section includes administrative and procedural requirements for alternates.

1.2 DEFINITIONS

- A. Alternate: An amount proposed by bidders and stated on the Bid Form for certain work defined in the bidding requirements that may be added to or deducted from the base bid amount if the Owner decides to accept a corresponding change either in the amount of construction to be completed or in the products, materials, equipment, systems, or installation methods described in the Contract Documents.
 - 1. Alternates described in this Section are part of the Work only if enumerated in the Agreement.
 - 2. The cost or credit for each alternate is the net addition to or deduction from the Contract Sum to incorporate alternates into the Work. No other adjustments are made to the Contract Sum.

1.3 PROCEDURES

- A. Coordination: Revise or adjust affected adjacent work as necessary to completely integrate work of the alternate into Project.
 - 1. Include as part of each alternate, miscellaneous devices, accessory objects, and similar items incidental to or required for a complete installation whether or not indicated as part of alternate.
- B. Execute accepted alternates under the same conditions as other work of the Contract.
- C. Schedule: A schedule of alternates is included at the end of this Section. Specification Sections referenced in schedule contain requirements for materials necessary to achieve the work described under each alternate.

PART 2 - PRODUCTS (Not Used)

PART 3 - EXECUTION

3.1 SCHEDULE OF ALTERNATES

- A. Alternate No. 1: Additional Parking and Stormwater Management
 - 1. Base Bid: Parking area as noted on the drawings.
 - Alternate: Install additional parking areas and associated construction including landscaping, pedestrian walkways, site lighting and cameras. The additional parking will also require the stormwater management system be installed. This will be inclusive of the pond, structures and all associated piping and appurtenances.
- B. Alternate No. 2: Site Lighting Poles along Excellence Drive.
 - 1. Base bid: No site lighting poles along this road.
 - Alternate:
 - a. Demo existing sign feeders back to building.
 - b. Install sign power circuit in 2#250KCMIL, 1#4/0 GND in 2" schd 80 PVC via lighting control relay LCP-R7. Downsize power conductors to 2#8, 1#10G inside J-boxes at each end.
 - c. Install fiber communication service in 2" schd 80PVC.
 - d. Install 2" schd 80PVC spare conduit.
 - e. Install (6) Pole lightings along roadway, feed from LP-18, via 2#10, 1#10G in 2" schd 80PVC.

END OF SECTION 012300

SECTION 02 41 16 - STRUCTURE DEMOLITION

PART 1 - GENERAL

1.1 RELATED DOCUMENTS

A. Drawings and general provisions of the Contract, including General and Supplementary Conditions and Division 01 Specification Sections, apply to this Section.

1.2 SUMMARY

A. Section Includes:

- 1. Demolition and removal of buildings.
- 2. Removing below-grade construction.
- 3. Disconnecting, capping or sealing, and removing site utilities.
- 4. Salvaging items for reuse by Owner.

B. Related Requirements:

1. Section 011000 "Summary" for use of the premises and phasing requirements.

1.3 DEFINITIONS

- A. Remove: Detach items from existing construction and dispose of them off-site unless indicated to be salvaged.
- B. Remove and Salvage: All items will be removed and disposed of no items will be salvaged during demolition.

1.4 MATERIALS OWNERSHIP

- A. Unless otherwise indicated, demolition waste becomes property of Contractor.
- B. Historic items, relics, antiques, and similar objects including, but not limited to, cornerstones and their contents, commemorative plaques and tablets, and other items of interest or value to Owner that may be uncovered during demolition remain the property of Owner.
 - 1. Carefully salvage in a manner to prevent damage and promptly return to Owner.

1.5 PREINSTALLATION MEETINGS

- A. Pre-demolition Conference: Conduct conference at Project site 3605 Center Rd, Brunswick, Ohio 44212.
 - 1. Review and finalize building demolition schedule and verify availability of demolition personnel, equipment, and facilities needed to make progress and avoid delays.
 - 2. Review and finalize protection requirements.
 - 3. Review procedures for noise control and dust control.
 - 4. Review procedures for protection of adjacent buildings.
 - 5. Review items to be salvaged and returned to Owner.

1.6 INFORMATIONAL SUBMITTALS

- A. Proposed Protection Measures: Submit report, including Drawings, that indicates the measures proposed for protecting individuals and property, for dust control and for noise control. Indicate proposed locations and construction of barriers.
- B. Schedule of Building Demolition Activities: Indicate the following:
 - 1. Detailed sequence of demolition work, with starting and ending dates for each activity.
 - 2. Temporary interruption of utility services.
 - 3. Shutoff and capping of utility services.
- C. Pre-demolition Photographs or Video: Show existing conditions of adjoining construction and site improvements, including finish surfaces, that might be misconstrued as damage caused by salvage and demolition operations.

1.7 FIELD CONDITIONS

- A. Buildings to be demolished will be vacated and their use discontinued before start of the Work.
- B. Buildings immediately adjacent to demolition area will be occupied. Conduct building demolition so operations of occupied buildings will not be disrupted.
 - 1. Provide not less than 72 hours' notice of activities that will affect operations of adjacent occupied buildings.
 - 2. Maintain access to existing walkways, exits, and other facilities used by occupants of adjacent buildings.
 - a. Do not close or obstruct walkways, exits, or other facilities used by occupants of adjacent buildings without written permission from authorities having jurisdiction.

- C. Hazardous Materials: It is not expected that hazardous materials will be encountered in the Work
 - 1. Hazardous materials will be removed by Owner before start of the Work.
 - 2. If materials suspected of containing hazardous materials are encountered, do not disturb; immediately notify Architect and Owner. Hazardous materials will be removed by Owner under a separate contract.
- D. On-site storage or sale of removed items or materials is not permitted.

1.8 COORDINATION

A. Arrange demolition schedule so as not to interfere with Owner's on-site operations or operations of adjacent occupied buildings.

PART 2 - PRODUCTS

2.1 PERFORMANCE REQUIREMENTS

- A. Regulatory Requirements: Comply with governing EPA notification regulations before beginning demolition. Comply with hauling and disposal regulations of authorities having jurisdiction.
- B. Standards: Comply with ANSI/ASSE A10.6 and NFPA 241.

PART 3 - EXECUTION

3.1 DEMOLITION CONTRACTOR

- A. Demolition Contractor:
 - 1. Insert, in separate subparagraphs, name of Contractor prequalified to perform the Work of this Section.

3.2 EXAMINATION

A. Verify that utilities have been disconnected and capped before starting demolition operations.

3.3 PREPARATION

- A. Refrigerant: Before starting demolition, remove refrigerant from mechanical equipment according to 40 CFR 82 and regulations of authorities having jurisdiction.
- B. Salvaged Items: Comply with the following:

1. All salvageable items will be removed by the college prior to demolition.

3.4 UTILITY SERVICES AND MECHANICAL/ELECTRICAL SYSTEMS

- A. Existing Utilities to be Disconnected: Locate, identify, disconnect, and seal or cap off utilities serving buildings and structures to be demolished.
 - 1. Owner will arrange to shut off utilities when requested by Contractor.
 - 2. Arrange to shut off utilities with utility companies.
 - If removal, relocation, or abandonment of utility services will affect adjacent occupied buildings, then provide temporary utilities that bypass buildings and structures to be demolished and that maintain continuity of service to other buildings and structures.
 - 4. Cut off pipe or conduit a minimum of 24 inches below grade. Cap, valve, or plug and seal remaining portion of pipe or conduit after bypassing according to requirements of authorities having jurisdiction.
 - 5. Do not start demolition work until utility disconnecting and sealing have been completed and verified in writing.

3.5 PROTECTION

- A. Existing Facilities: Protect adjacent walkways, loading docks, building entries, and other building facilities during demolition operations. Maintain exits from existing buildings.
- B. Temporary Shoring: Provide and maintain interior and exterior shoring, bracing, or structural support to preserve stability and prevent unexpected movement or collapse of construction being demolished.
 - 1. Strengthen or add new supports when required during progress of demolition.
- C. Existing Utilities to Remain: Maintain utility services to remain and protect from damage during demolition operations.
 - 1. Do not interrupt existing utilities serving adjacent occupied or operating facilities unless authorized in writing by Owner and authorities having jurisdiction.
 - 2. Provide temporary services during interruptions to existing utilities, as acceptable to Owner and authorities having jurisdiction.
 - a. Provide at least 72 hours' notice to occupants of affected buildings if shutdown of service is required during changeover.
- D. Temporary Protection: Erect temporary protection, such as walks, fences, railings, canopies, and covered passageways, where required by authorities having jurisdiction and as indicated. Comply with requirements in Section 015000 "Temporary Facilities and Controls."
 - 1. Protect adjacent buildings and facilities from damage due to demolition activities.
 - 2. Protect existing site improvements, appurtenances, and landscaping to remain.

- 3. Erect a plainly visible fence around drip line of individual trees or around perimeter drip line of groups of trees to remain.
- 4. Provide temporary barricades and other protection required to prevent injury to people and damage to adjacent buildings and facilities to remain.
- 5. Provide protection to ensure safe passage of people around building demolition area and to and from occupied portions of adjacent buildings and structures.
- 6. Protect walls, windows, roofs, and other adjacent exterior construction that are to remain and that are exposed to building demolition operations.
- 7. Erect and maintain dustproof partitions and temporary enclosures to limit dust, noise, and dirt migration to occupied portions of adjacent buildings.
- E. Remove temporary barriers and protections where hazards no longer exist. Where open excavations or other hazardous conditions remain, leave temporary barriers and protections in place.

3.6 DEMOLITION, GENERAL

- A. General: Demolish indicated buildings and site improvements completely. Use methods required to complete the Work within limitations of governing regulations and as follows:
 - 1. Do not use cutting torches until work area is cleared of flammable materials. Maintain portable fire-suppression devices during flame-cutting operations.
 - 2. Maintain fire watch during and for at least 3 hours after flame-cutting operations.
 - 3. Maintain adequate ventilation when using cutting torches.
 - 4. Locate building demolition equipment and remove debris and materials so as not to impose excessive loads on supporting walls, floors, or framing.
- B. Site Access and Temporary Controls: Conduct building demolition and debris-removal operations to ensure minimum interference with roads, streets, walks, walkways, and other adjacent occupied and used facilities.
 - 1. Do not close or obstruct streets, walks, walkways, or other adjacent occupied or used facilities without permission from Owner and authorities having jurisdiction. Provide alternate routes around closed or obstructed trafficways if required by authorities having jurisdiction.
 - Use water mist and other suitable methods to limit spread of dust and dirt. Comply with governing environmental-protection regulations. Do not use water when it may damage adjacent construction or create hazardous or objectionable conditions, such as ice, flooding, and pollution.
- C. Explosives: Use of explosives is not permitted.

3.7 DEMOLITION BY MECHANICAL MEANS

A. Proceed with demolition of structural framing members systematically, from higher to lower level. Complete building demolition operations above each floor or tier before disturbing supporting members on the next lower level.

- B. Remove debris from elevated portions of the building by chute, hoist, or other device that will convey debris to grade level in a controlled descent.
 - 1. Remove structural framing members and lower to ground by method suitable to minimize ground impact and dust generation.
- C. Salvage: Items to be removed and salvaged will be done so prior to demolition by the college.
- D. Below-Grade Construction: Demolish foundation walls and other below-grade construction.
 - 1. Remove below-grade construction, including basements, foundation walls, and footings, completely.
- E. Existing Utilities: Demolish and remove existing utilities and below-grade utility structures that are not being reused for new construction.

3.8 SITE RESTORATION

A. Below-Grade Areas: Completely fill below-grade areas and voids resulting from building demolition operations with satisfactory soil materials and compacted every 8" installed in loose lifts to grade. The fill should be compacted to a minimum of 98% of the maximum dry density within +/- 2% of the optimum moisture content as determined by by ASTM D-698. There is not a basement in the existing church. Site to be graded to be ready to accept new paved areas.

3.9 REPAIRS

A. Promptly repair damage to adjacent buildings caused by demolition operations.

3.10 DISPOSAL OF DEMOLISHED MATERIALS

- A. Remove demolition waste materials from Project site and dispose of them in an EPAapproved construction and demolition waste landfill acceptable to authorities having jurisdiction. Recycle or dispose of them according to Section 017419 "Construction Waste Management and Disposal."
 - 1. Do not allow demolished materials to accumulate on-site.
 - 2. Remove and transport debris in a manner that will prevent spillage on adjacent surfaces and areas.
- B. Do not burn demolished materials.

3.11 CLEANING

- A. Clean adjacent structures and improvements of dust, dirt, and debris caused by building demolition operations. Return adjacent areas to condition existing before building demolition operations began.
 - 1. Clean roadways of debris caused by debris transport.

END OF SECTION 02 41 16


Section 02 41 16 Structure Demolition


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BID QUESTIONS LOG - 05-11-21

Cuyahoga Community College Brunswick Building Demolition and New Parking Lot

RFI#	DATE RECEIVED	FROM		QUESTION	RESPONSE	REW/CLIENT
1	4/29/2021	Sitetech	Rick Kuehn	Referencing drawings C-200 Site Demo Plan and C-400 Site Plan. The demo drawing shows all existing asphalt paving to be removed where the site plan shows an area of the existing asphalt to remain and be milled and then overlayed. Could you please clarify which way to proceed?	Demo should read "EX. ASPHALT PVMT. SURFACE COURSES REMOVED" (MIN. 3")	MJC
2	5/4/2021	Fabrizi Trucking and Paving	Alex DiNigris	Drawing C-400 shows the existing asphalt parking lot to be resurfaced but on the demolition plan C-200 it calls for removal of asphalt pavement. Is this new pavement or resurface?	Demo should read "EX. ASPHALT PVMT. SURFACE COURSES REMOVED" (MIN. 3")	MJC
3	5/6/2021	E-Lighting Controls	Lisa Wallbrown	Can we quote an equal package to the attached LSI spec	This substitution has been incorporated into Addendum 1	RPL
4	5/6/2021	Infinity Paving	Jeff Jones	Is there a narrative that spells out the scope of work for each of the 2 bid packages – BP 1 Church Demo and BP 2 Sitework?	BP 1: is the demolition of the church and finish to grade. BP 2: Is the remainder of the site improvements	JRK
4	5/6/2021	Infinity Paving	Jeff Jones	What is the finish grade the church will be left at once demo'd? We will need this info to figure out the earthwork quantities.	See specification section 024116 Section 3.8 and C200 for more information.	MJC
4	5/6/2021	Infinity Paving	Jeff Jones	Are there soil borings available or information on the thickness of the existing pavements?	We don't have this information.	JRK/MJC
5	5/6/2021	Nerone	Jayesh Dharia	Are we allowed to bid package 2- Site work only? Or do we have to bid both packages Package 1 and package 2 -combined as shown on bid form.	Yes you can bid one or both of the bid packages listed.	JRK
5	5/6/2021	Nerone	Jayesh Dharia	Please provide details of proposed monument sign.	The actual sign is not included in this bid package. Site work and utilities are included.	JRK
6	5/7/2021	Fabrizi Trucking and Paving	Alex DiNigris	Do we need Professional Liability Insurance	Yes	JRK



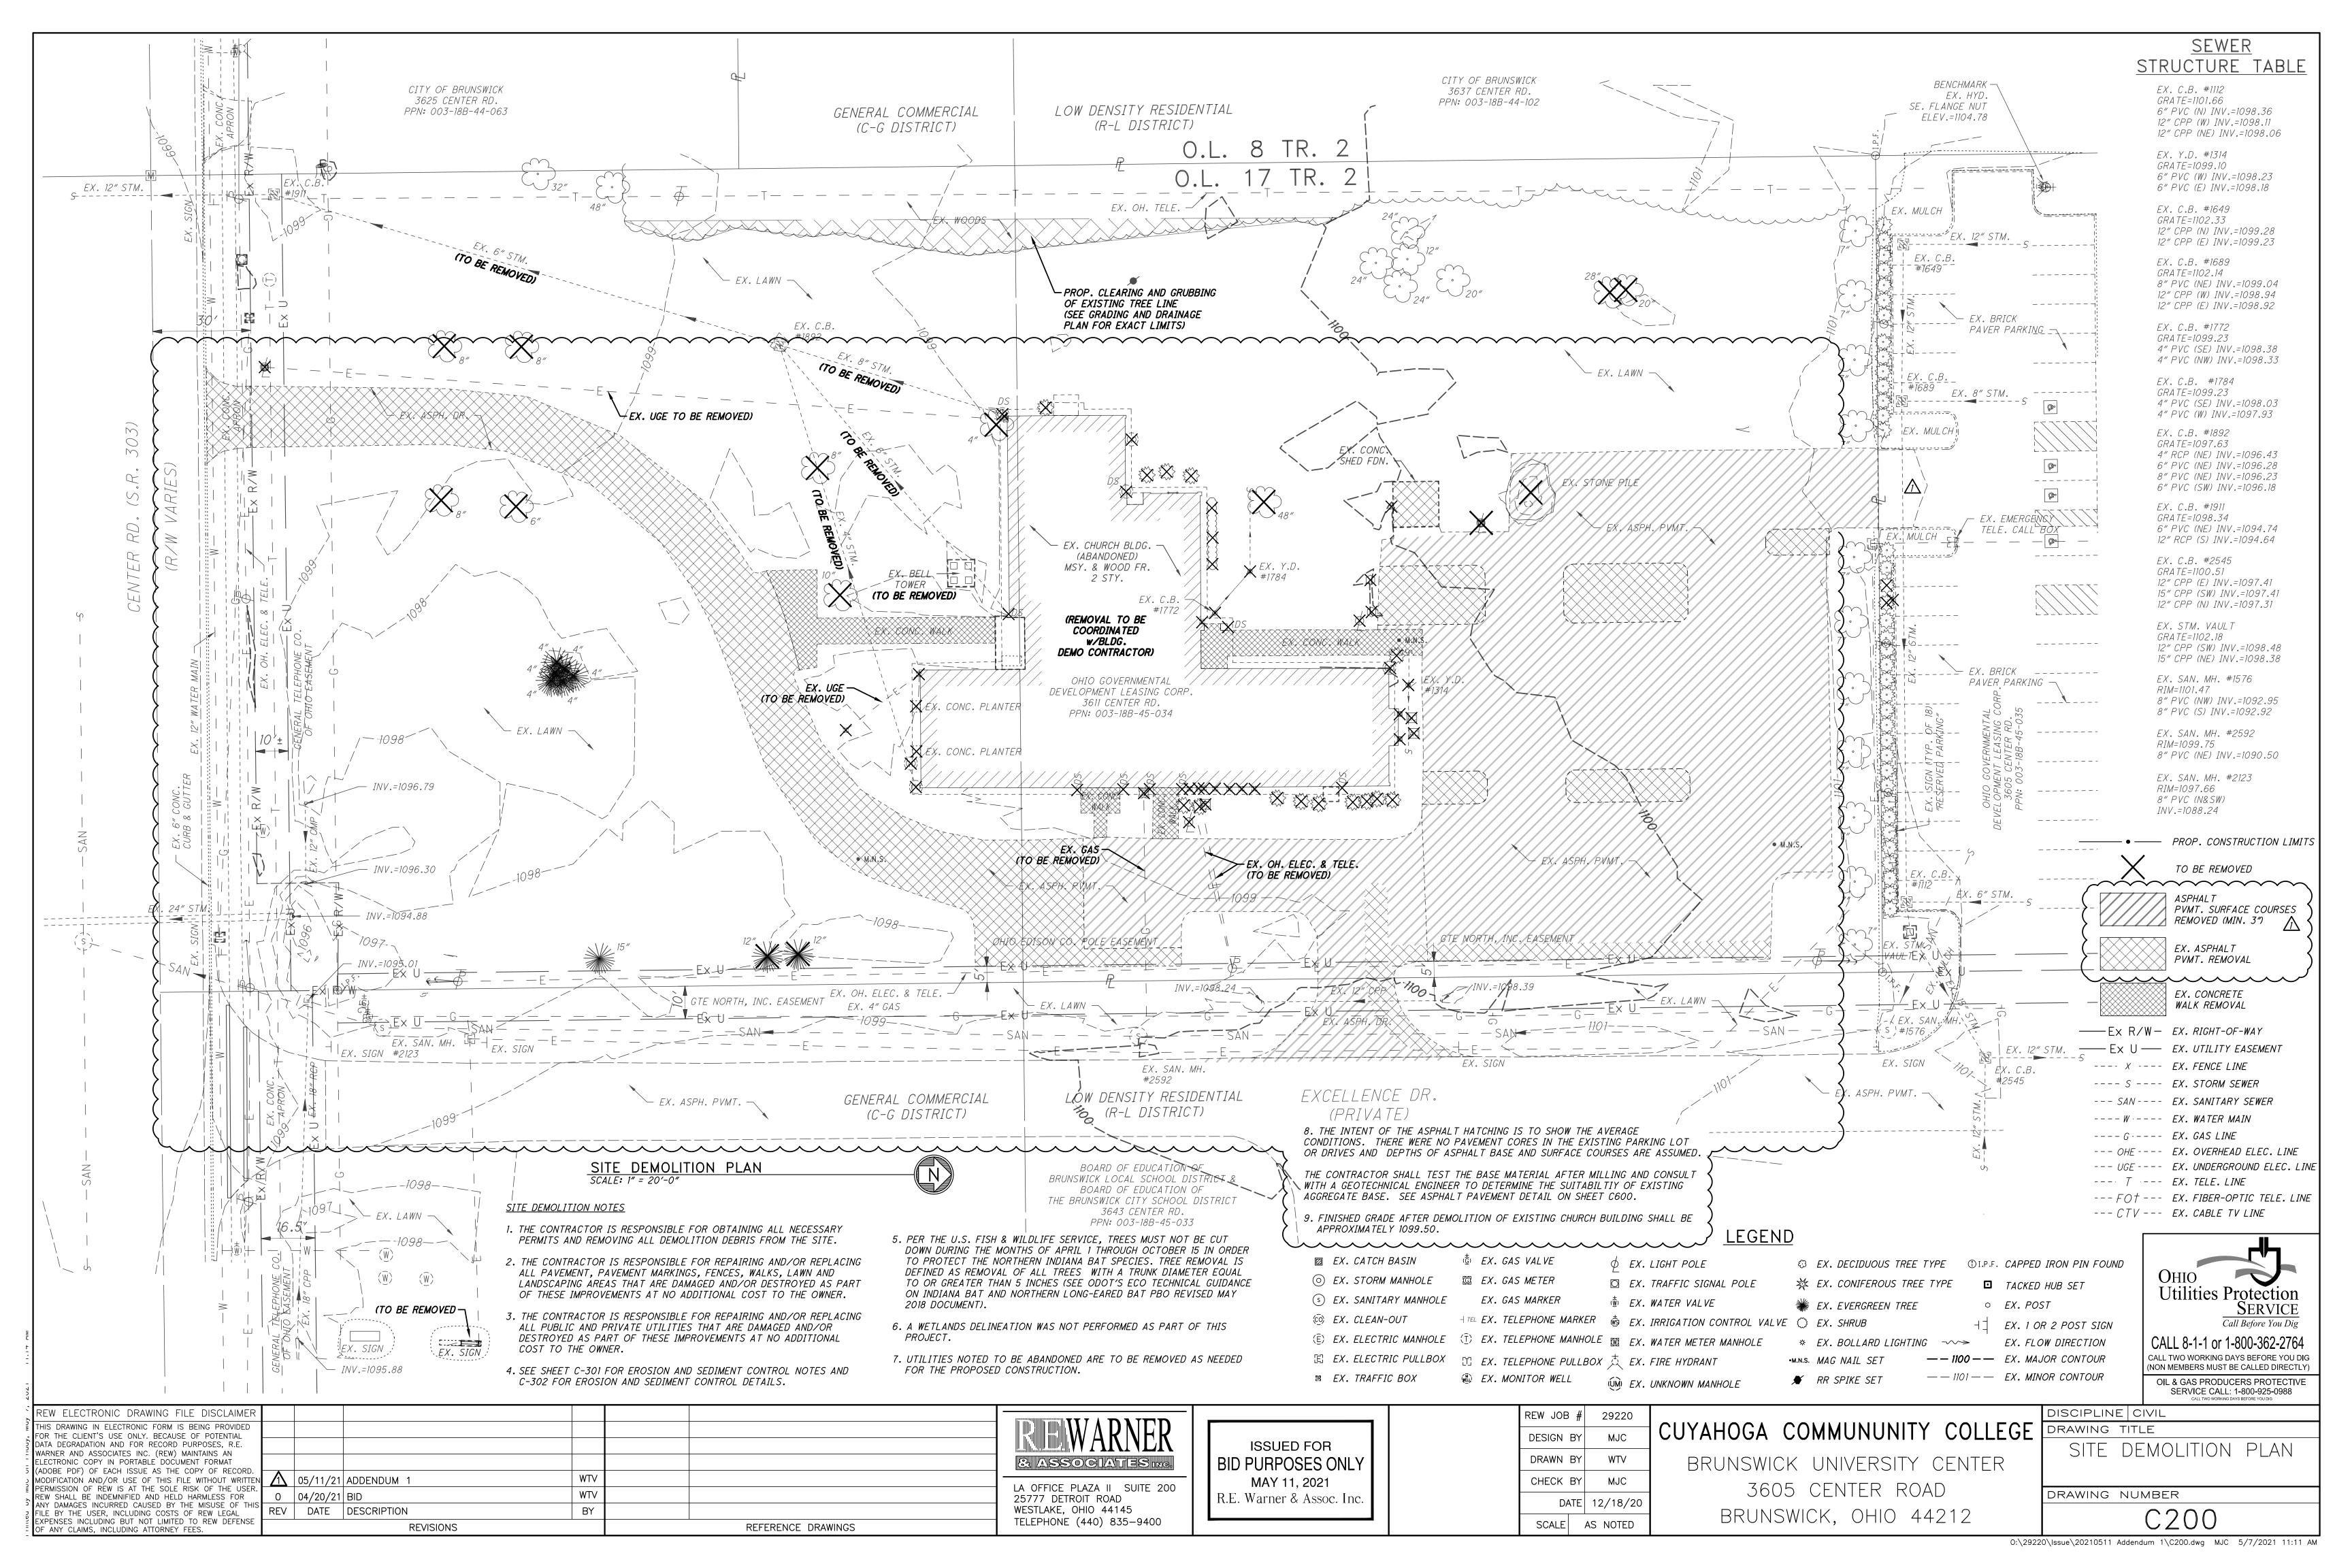

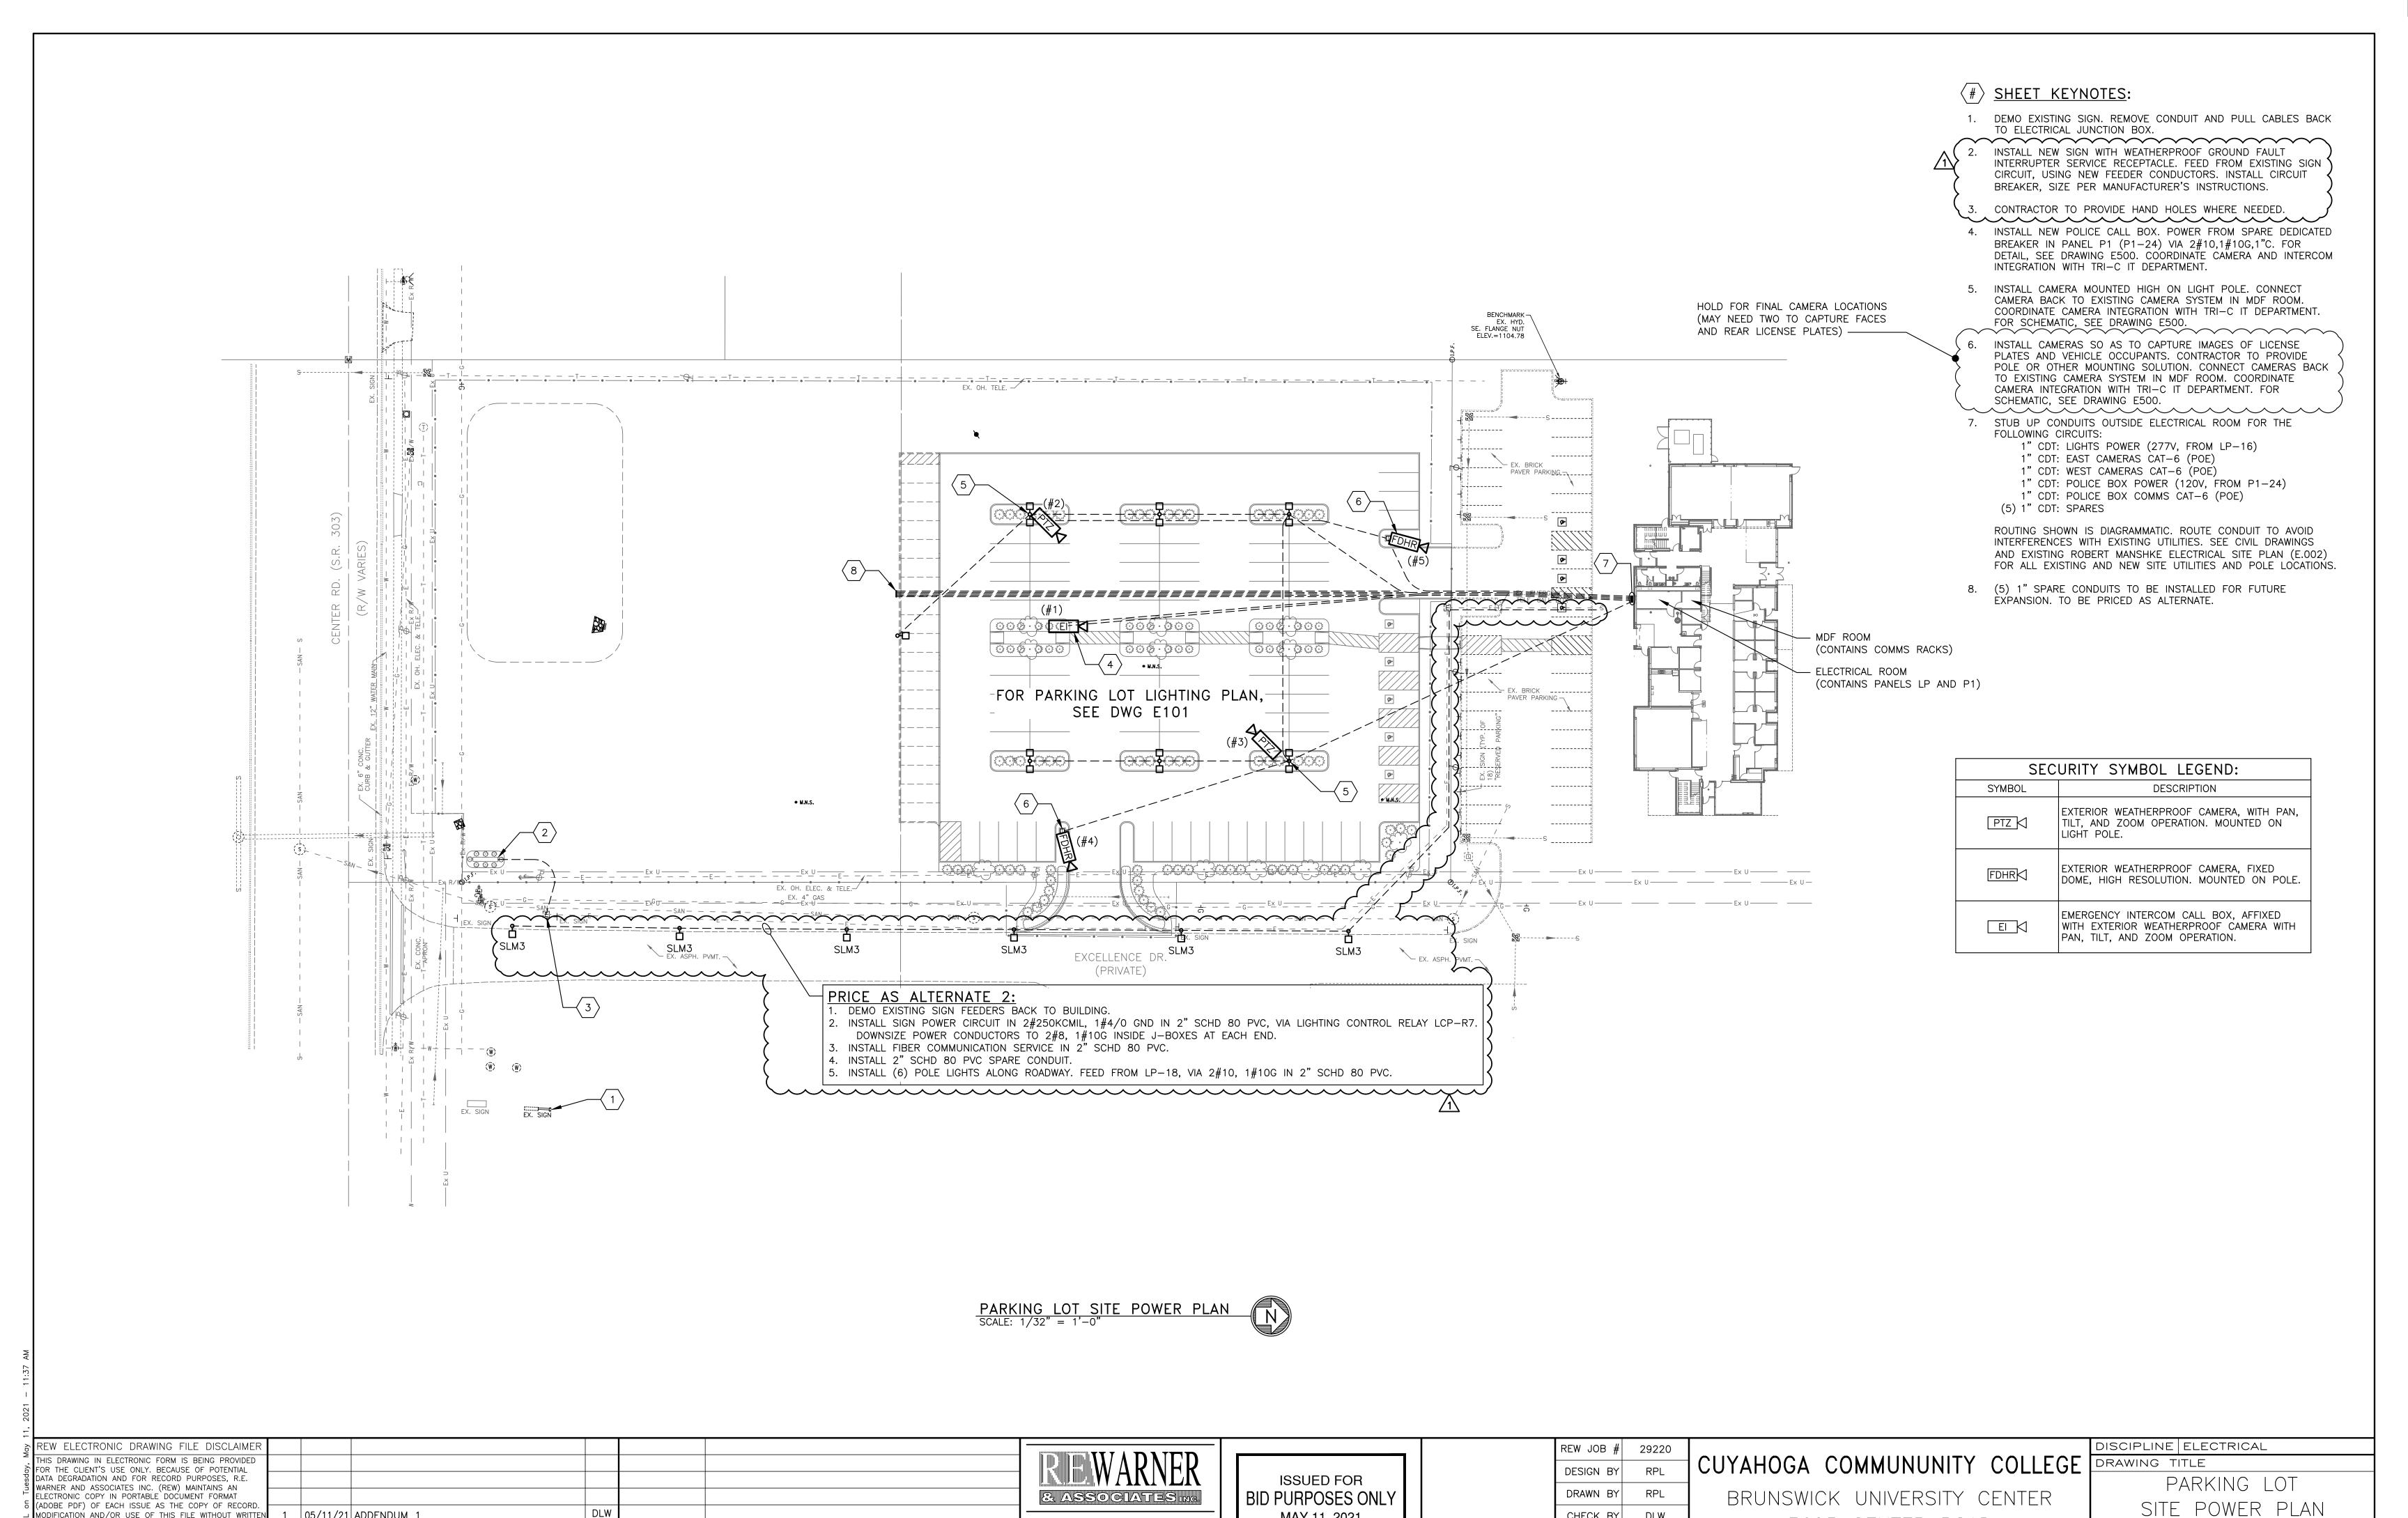MAY 11, 2021

R.E. Warner & Assoc. Inc.

LA OFFICE PLAZA II SUITE 200

TELEPHONE (440) 835-9400

25777 DETROIT ROAD

WESTLAKE, OHIO 44145

CHECK BY

DATE 01/07/21

SCALE AS NOTED

3605 CENTER ROAD

BRUNSWICK, OHIO 44212

1 05/11/21 ADDENDUM 1

REV DATE DESCRIPTION

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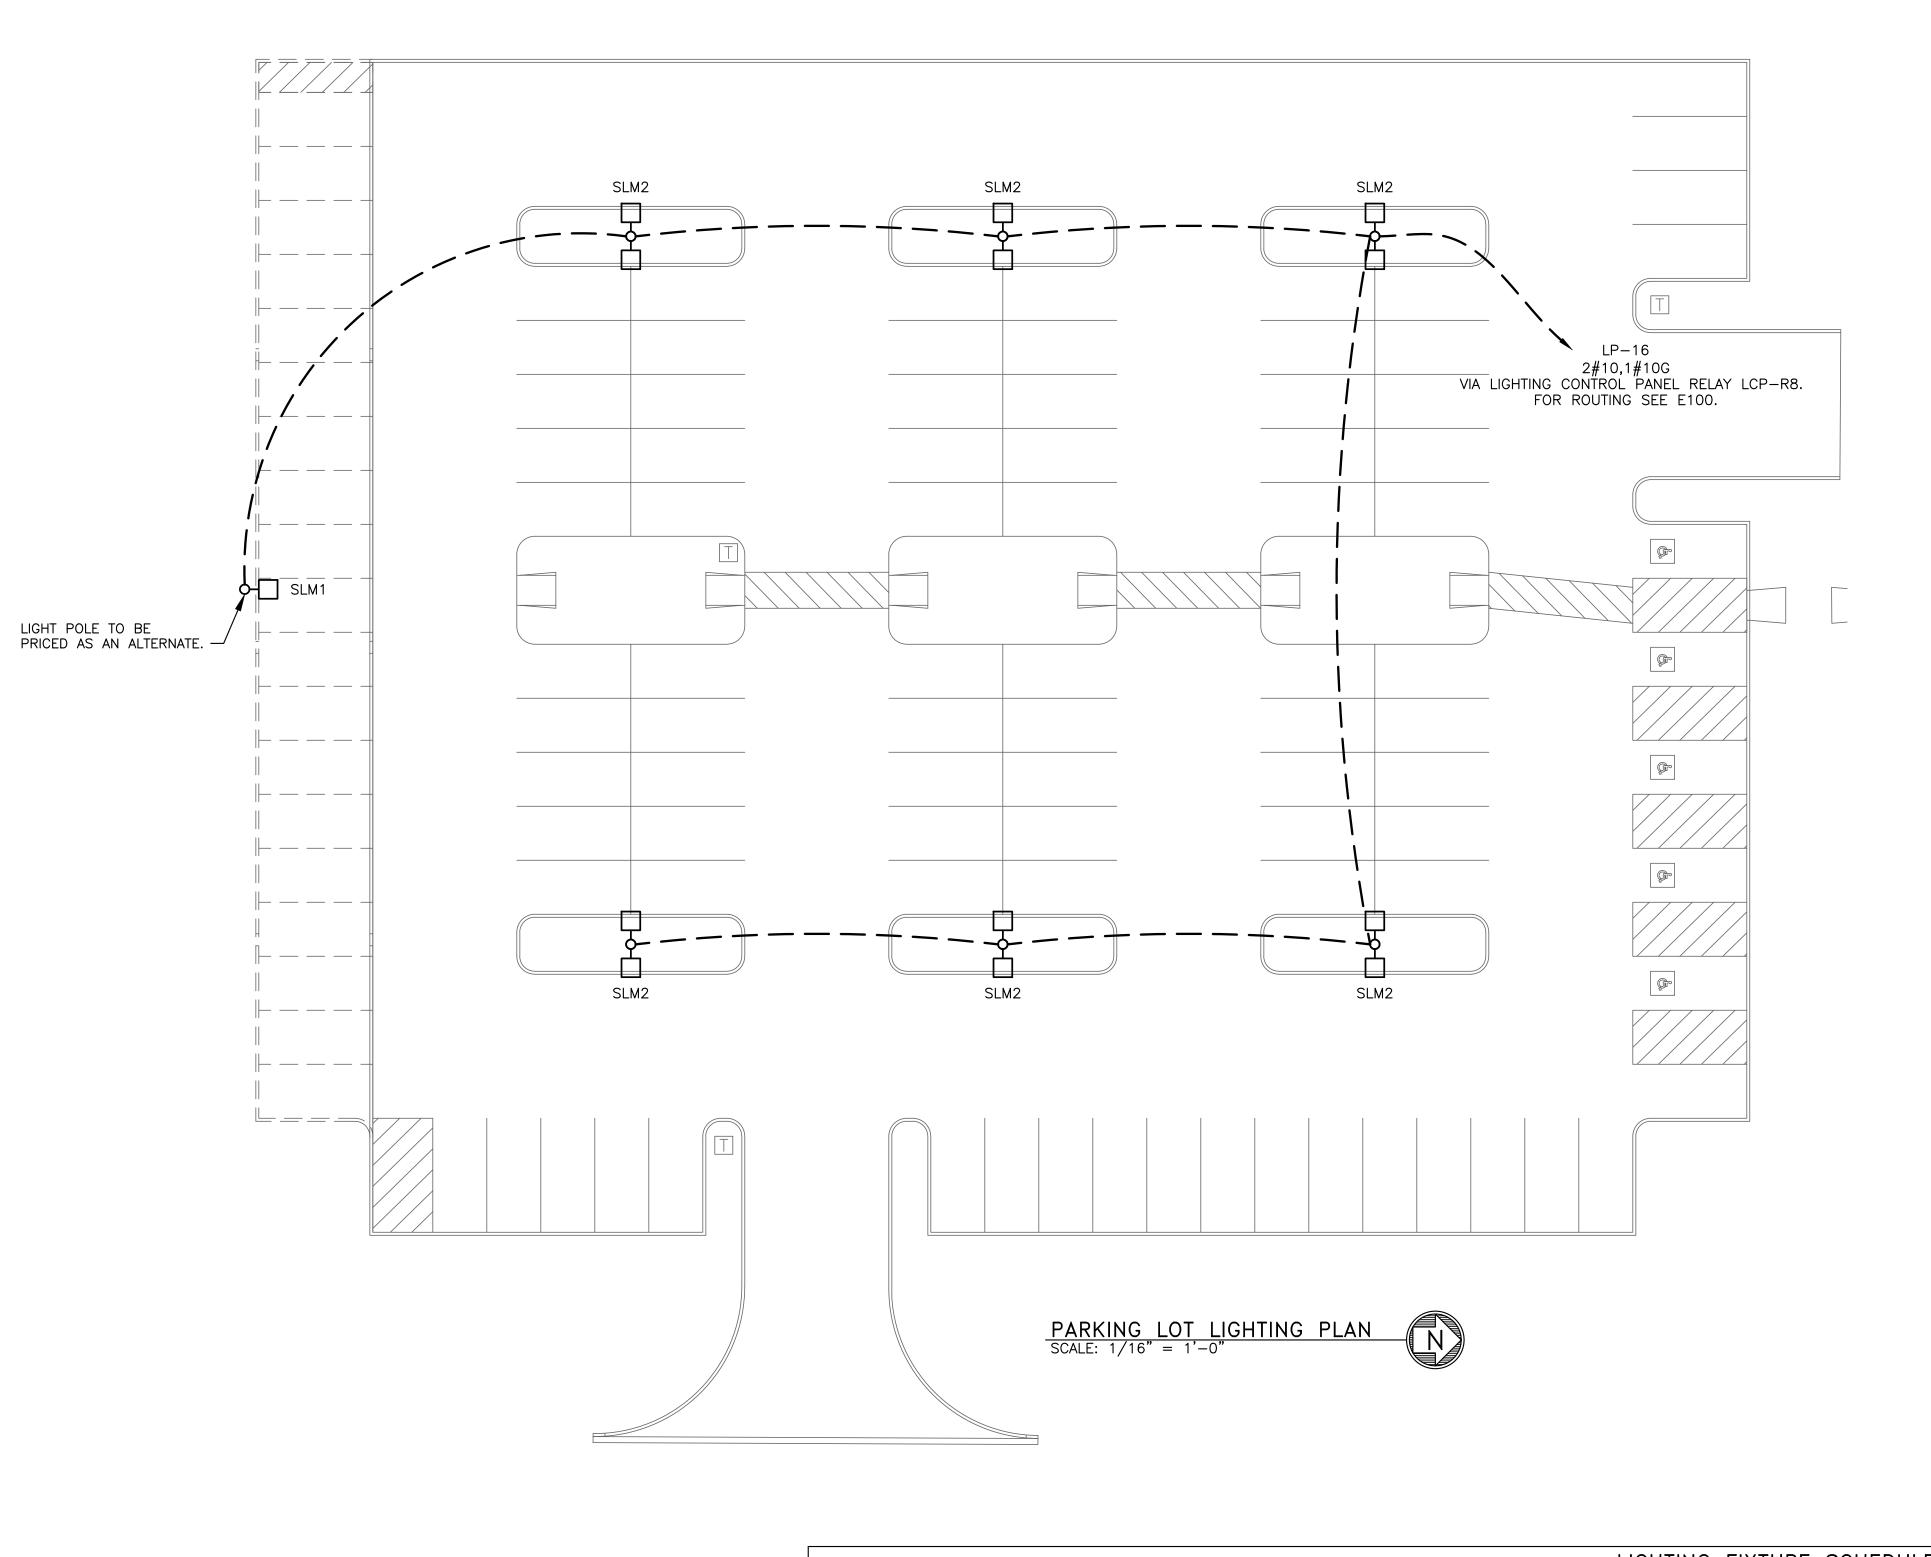
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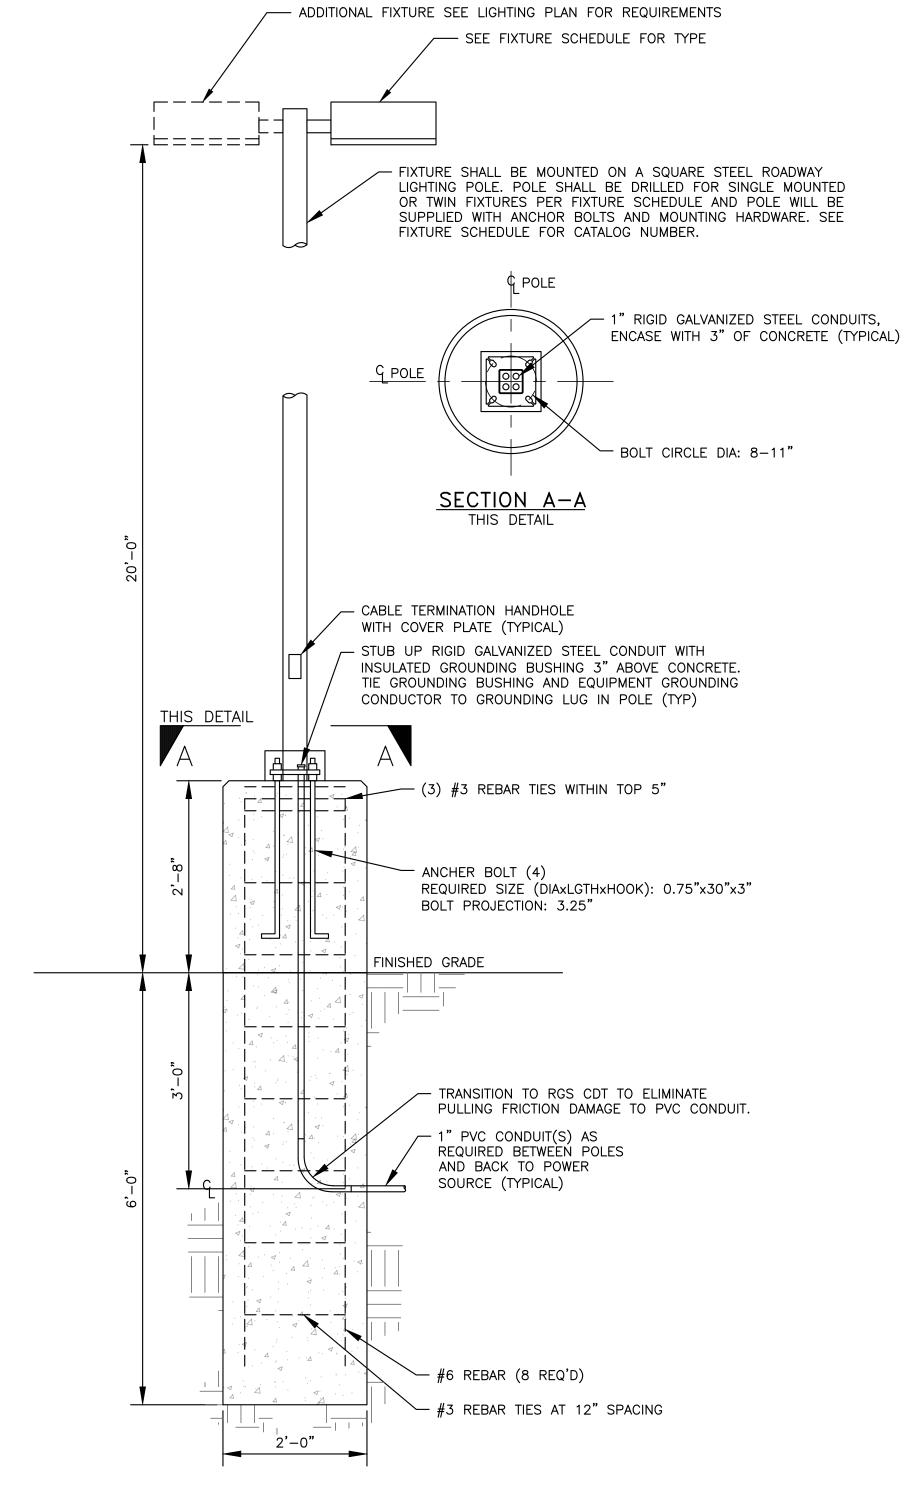
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E100

DRAWING NUMBER





TYPICAL POLE DETAIL
SCALE: 3/4"=1'-0"

	LIGHTING FIXTURE SCHEDULE							
TYPE SYMBOL		SYMPOL LUM		LAMP TYPE	DESCRIPTION	MOUNTING		MANUFACTURER
IIFE	STMBOL	WATTS	VOLTS	LAMP TIPE	DESCRIPTION	MOUNTING	NAME	CATALOG NUMBER
SLM1	о —	135	120-277	LED 4000K 18,000 LUMENS	POLE MOUNTED PARKING LOT FIXTURE, DIE CAST ALUMINUM HOUSING, WITH SILICONE LENSES AND INTEGRAL HOUSE SIDE SHIELD. 18'x4"x4" SQUARE STEEL POLE. TYPE 3 DISTRIBUTION.	POLE MOUNT, 20'-0" ABOVE GRADE	LSI INDUSTRIES	'SLM LED 18L SIL 3 UNV DIM 40 70CRI XXX ¹ IH' FIXTURE WITH '4SQ B3 S11G 18 S XXX ¹ ' POLE
SLM2		(2)x135	120-277	LED 4000K 18,000 LUMENS	SAME AS SLM1, BUT WITH 2 FIXTURES PER POLE	POLE MOUNT, 20'-0" ABOVE GRADE	LSI INDUSTRIES	TWO (2) 'SLM LED 18L 3 UNV DIM 40 70CRI XXX1' FIXTURES WITH '4SQ B3 S11G 18 D180 XXX1' POLE
SLM3		135	120-277	LED 4000K 18,000 LUMENS	SAME AS SLM1, BUT WITH A TYPE 2 DISTRIBUTION AND INTEGRAL LOUVER FOR LIGHT CUTOFF.	POLE MOUNT, 20'-0" ABOVE GRADE	LSI INDUSTRIES	'SLM LED 18L SIL 2 UNV DIM 40 70CRI XXX ¹ IL' FIXTURE WITH '4SQ B3 S11G 18 S XXX ¹ ' POLE

1 XXX INDICATES FINISH, TO BE COORDINATED WITH OWNER.

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	BID PURPOSES ONLY
	MAY 11, 2021
	R.E. Warner & Assoc. Inc.

REW JOB #	29220
DESIGN BY	RPL
DRAWN BY	RPL
CHECK BY	DLW
DATE	01/07/21

SCALE AS NOTED

CUYAHOGA COMMUNUNITY COLLEGE

BRUNSWICK UNIVERSITY CENTER 3605 CENTER ROAD BRUNSWICK, OHIO 44212

DISCIPLINE ELECTRICAL
DRAWING TITLE
PARKING LOT
LIGHTING PLAN
DRAWING NUMBER
E101

PLAT OF CONSOLIDATION **FOR** CUYAHOGA COMMUNITY COLLEGE 50' 150' 2001 100' **BRUNSWICK CAMPUS** BEING A PART OF ORIGINAL BRUNSWICK TOWNSHIP LOT NO. 17, TRACT NO. 2 50'-0" SCALE: IN TOWNSHIP 4, RANGE 14 OF THE CONNECTICUT WESTERN RESERVE NOW SITUATED IN THE CITY OF BRUNSWICK, COUNTY OF MEDINA, OHIO CITY OF BRUNSWICK CITY OF BRUNSWICK 3625 CENTER RD. 3637 CENTER RD. O.R. VOL. 573, P. 877 BASIS OF BEARINGS 3/4" I.P. FD. 1" I.P. FD. 0.12' N 5/8″ I.P. FD. & USED THE BASIS OF BEARINGS ARE THE WESTERLY LINE OF & USED 0.64' E "DEMPSEY #6914" 670.00' ORIGINAL BRUNSWICK TOWNSHIP LOT NO. 17 ASSUMED FROM LOT 8 TR. 2 LOT 7 TR. 2 MEDINA COUNTY ENGINEER'S RECORDS BOOK 46, PAGE 46. N 00°39′40″ W 498.00 LOT 17 TR. 2 LOT 18: TR. 2 (N 00° 39' 40" W) DEFINED BY MONUMENTATION SHOWN 5/8" I.P. FD. HEREON. 0.06' N 0.40' E (R.) RECORD (C.) CALCULATED OHIO GOVERNMENTAL DEVELOPMENT LEASING CORP. 3611 CENTER ROAD REFERENCES (VACANT CHURCH TO BE DEMOLISHED) 2.8393 AC. (123,680 S.F.) PLAT OF SURVEY AND LOT SPLIT BY CT CONSULTANTS 11/26/2019 MEDINA COUNTY ENGINEER'S RECORDS BOOK 46, PAGE 46. 2019OR024821 CANC. DOCUMENT #2019OR024826 [[]] OHIO GOVERNMENTAL MEDINA COUNTY RECORDER'S RECORDS DEVELOPMENT LEASING CORP ASSIG. DOCUMENT #2017OR004740 3605 CENTER ROAD MEDINA COUNTY RECORDER'S RECORDS 0.9871 AC. (43,000 S.F.) %" I.P. FD. & USED DEEDS AND PLATS AS SHOWN, MEDINA COUNTY RECORDER'S RECORDS. 5/10/2011 "DEMPSEY #6914" 2011OR009863 S 00°29'40" E **APPROVALS** 25.00′ 5/8" I.P. FD. & USED THIS PLAT OF CONSOLIDATION IS HEREBY APPROVED BY THE OHIO EDISON CO. EASEMENT "DEMPSEY #6914" PLANNING COMMISSION OF THE CITY OF BRUNSWICK, OHIO. O.R. WOL. 609, P. 190 & GTE NORTH, INC. EASEMENT OHIO EDISON CO. POLE EASEMENT S 89°30′20″ W O.R. VOL. 585, P. 356 is is VOL. 284, P. 367 32.83′ **:** □ TX 3.9'40" F 172.00' R.&L CHAIRMAN CITY OF BRUNSWICK PLANNING COMMISSION 15' OFFSET 5/8" I.P. FD. & US <u>5/8" I.P. FD. & USED</u> UGE CABLE AND "DEMPSEY #6914" GTE NORTH, INC. EASEMENT THIS PLAT OF CONSOLIDATION IS HEREBY APPROVED BY THE EXCELLENCE DR. TRANSFORMER LOCATED O.R. VOL. 604, P. 928 ENGINEER OF THE CITY OF BRUNSWICK, OHIO. AT PROPERTY CORNER (PRIVATE) BOARD OF EDUCATION'OF BRUN\$WICK \LOCAL SCHOOL D\STRICT & **ENGINEER** ' BOARD OF EDUCATION OF CITY OF BRUNSWICK THE BRUNSWICK CITY SCHOOL DISTRICT 3643 CENTER RD. SURVEYOR'S CERTIFICATION DEED VOL. 282, P. 139 2/23/1961 DEED VOL. 456, P. 660-663 6/10/1974 R ≥ I HEREBY STATE THAT THIS PLAT IS BASED ON AN ACTUAL \supset FIELD SURVEY CONDUCTED BY ME AND TO THE BEST OF MY PROFESSIONAL KNOWLEDGE, INFORMATION, AND BELIEF, THE SURVEY SHOWN HEREON WAS MADE IN ACCORDANCE WITH THE REQUIREMENTS OF CHAPTER 4733-37 STANDARD FOR

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A 05/11/21 CITY REVIEW

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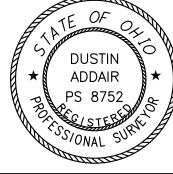
MJC

BY

AREA TABLE				
	PARCEL -034	PARCEL -035	TOTAL (ACRES)	
CONSOLIDATION	2.8393	0.9871	3.8264	

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MSSO GIATES NG



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	DRAWN BY	MJC
	CHECK BY	DRA
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BRUNSWICK UNIVERSITY CENTER 3605 CENTER ROAD BRUNSWICK, OHIO 44212

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AND MEETS OR EXCEEDS THE REQUIREMENTS FOR A

BOUNDARY SURVEY AS SPECIFIED THEREIN.

OHIO PROFESSIONAL LAND SURVEYOR NO. 8752

DUSTIN R. ADDAIR

LEGEND

• M.N.S. MAG NAIL SET

OI.P.F. IRON PIN FOUND

●I.P.S. 5/8" CAPPED IRON PIN SET " REWARNER"

MONUMENT BOX FOUND

① I.P.F. CAPPED IRON PIN FOUND

EX. RIGHT-OF-WAY

EX. UTILITY EASEMENT

EX. CHANNEL EASEMENT

EX. CENTERLINE R/W EX. PROPERTY LINE

PLAT OF CONSOLIDATION

DATE

DATE

DATE

DRAWING NUMBER

SV001